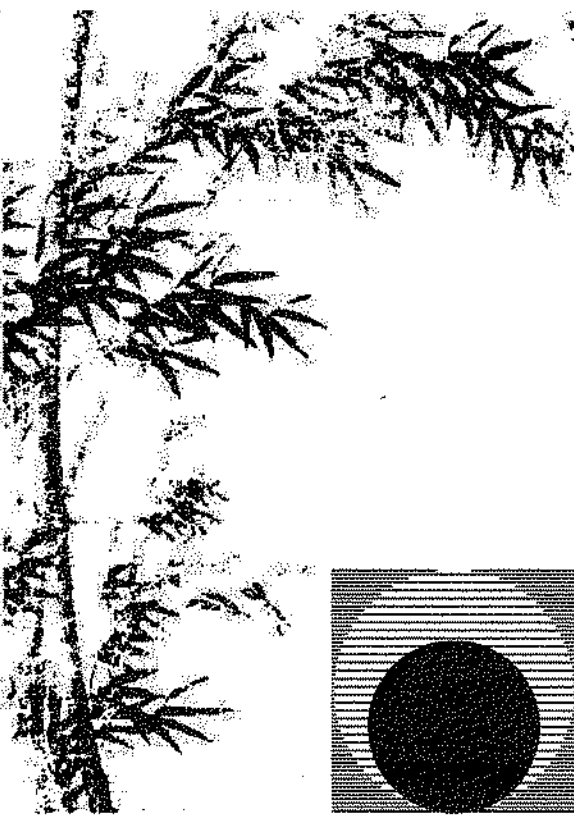


Master Site Plan

KEY NOTES (THIS SHEET ONLY)

- | | |
|---|---|
| ① (N) POWER FEED FOR ANTENNA TOWER BUILDING: (N) BREAKER AT SPARE AT (E) MAIN POWER PANEL - RUN (N) CONDUIT NORTH TO AREA OF PROJECT - REFER TO ELECTRICAL SHEETS | ⑫ RUN (N) CONDUIT TO PATIO COVER - PAINT TO MATCH |
| ② (N) POWER FEED TO TOWER BUILDING - REFER TO ELECTRICAL SHEETS | ⑬ SECURE (N) CONDUIT TO PATIO COVER - PAINT TO MATCH |
| ③ (N) TOWER BUILDING AS DESIGNED BY OTHERS | ⑭ DROP (N) CONDUIT DOWN COLUMN OF (E) PATIO COVER - PAINT TO MATCH |
| ④ (N) ANTENNA TOWER AS DESIGNED BY OTHERS | ⑮ CUT (E) CONCRETE AND/OR ASPHALT AS REQUIRED FOR (N) CONDUIT INSTALLATION - PATCH TO MATCH |
| ⑤ (E) FENCE TO REMAIN - PROTECT | ⑯ (E) SPEED BUMPS - CUT/PATCH ASPHALT AS REQUIRED |
| ⑥ (E) TREE TO REMAIN - PROTECT | ⑰ (E) SUPPORTS FOR (E) SOLAR COVERS - TYP. - PROTECT |
| ⑦ (E) POLE-MOUNTED LIGHT TO REMAIN - PROTECT | ⑱ APPROXIMATE LOCATION OF (E) UNDERGROUND SITE LIGHTING FEEDS BASED ON RECORD DRAWINGS PROVIDED BY THE OWNER - VERIFY AND PROTECT - THE CONTRACTOR BEARS THE SOLE RESPONSIBILITY FOR IDENTIFYING AND PROTECTING ALL (E) UNDERGROUND UTILITIES |
| ⑧ (E) TRASH ENCLOSURE TO REMAIN - PROTECT | |
| ⑨ (E) STORAGE TRAILER TO BE MOVED TO THIS LOCATION BY OWNER - PROTECT | |
| ⑩ (N) TRAFFIC BOLLARDS PER (S) SD2 TYPICAL FOR (12) | |
| ⑪ CORE (E) WALL TO DAYLIGHT (N) CONDUIT TO EXTERIOR FACE | |

SCALE: 1" = 50'-0"




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Consultant:

Drawing Status:

Contract Document

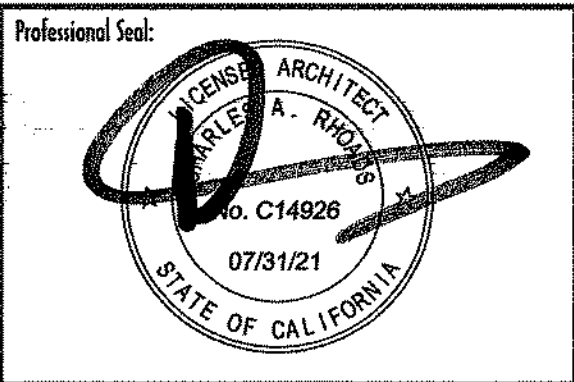Revision Summary:

Project:


**New Dispatch Center
Tulare County Sheriff & Fire
5300 West Tulare Avenue
Visalia, California**

Sheet Description:

Master Site Plan


Date:	08/08/20
Project:	19-700
Scale:	1" = 50'
Sheet No.:	SD1

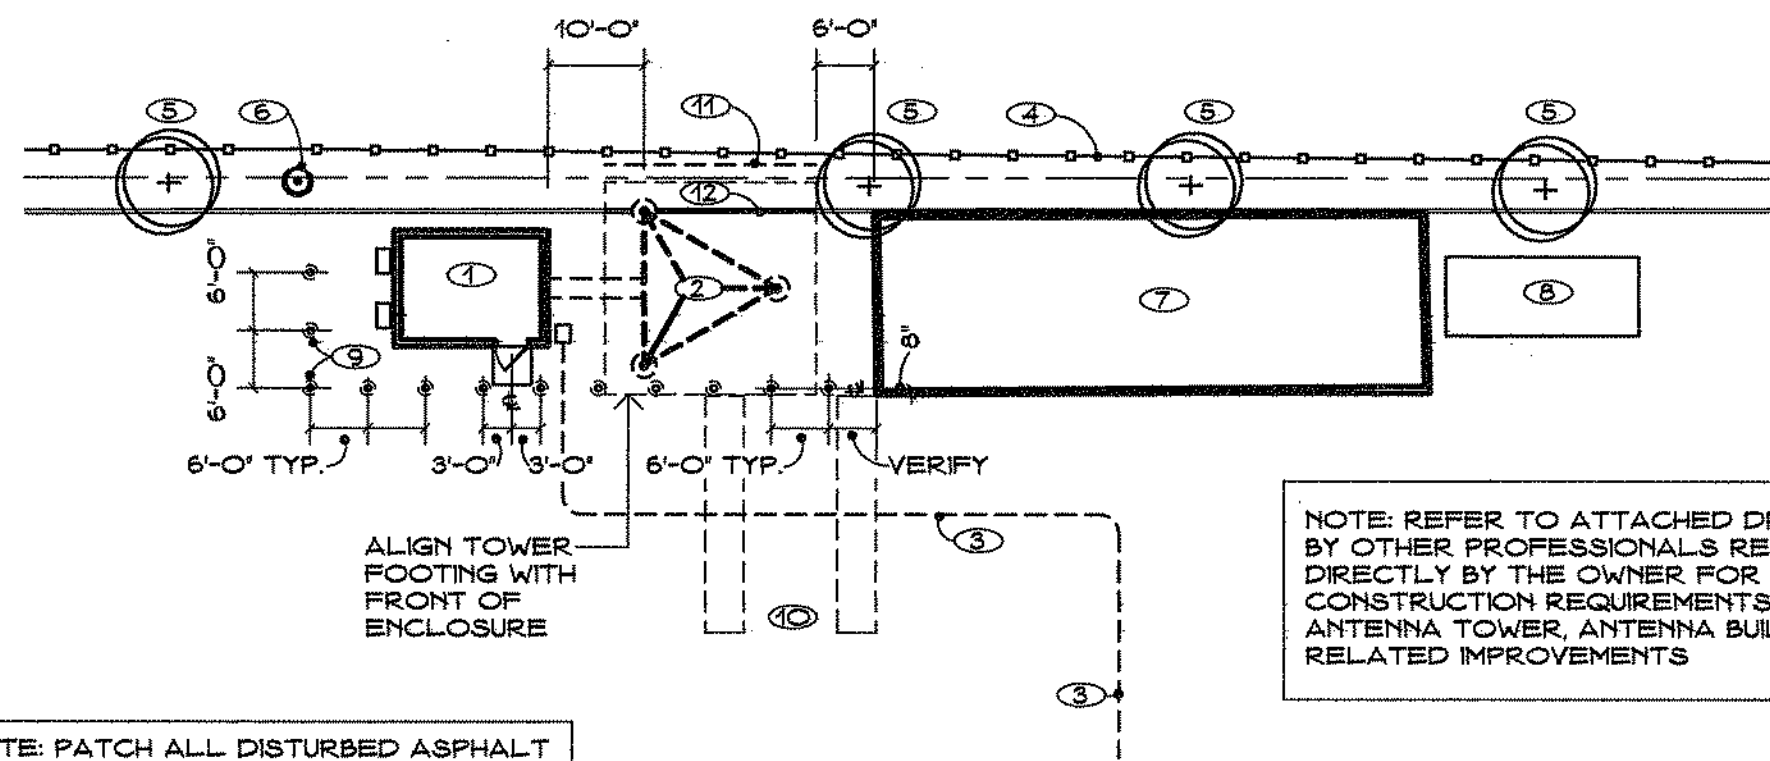Of 2 Sheets



NOTE: PATCH ALL DISTURBED ASPHALT SURFACES TO MATCH USING SAME PROFILE AND GRADES AS EXISTING

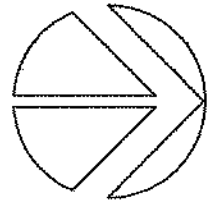NOTE: REFER TO ATTACHED DRAWINGS BY OTHER PROFESSIONALS RETAINED DIRECTLY BY THE OWNER FOR THE CONSTRUCTION REQUIREMENTS FOR THE ANTENNA TOWER, ANTENNA BUILDING, AND RELATED IMPROVEMENTS




SCALE: 1" = 20'-0"


2 ENLARGED SITE PLAN - NEW CONSTRUCTION

KEY NOTES (THIS SHEET ONLY)

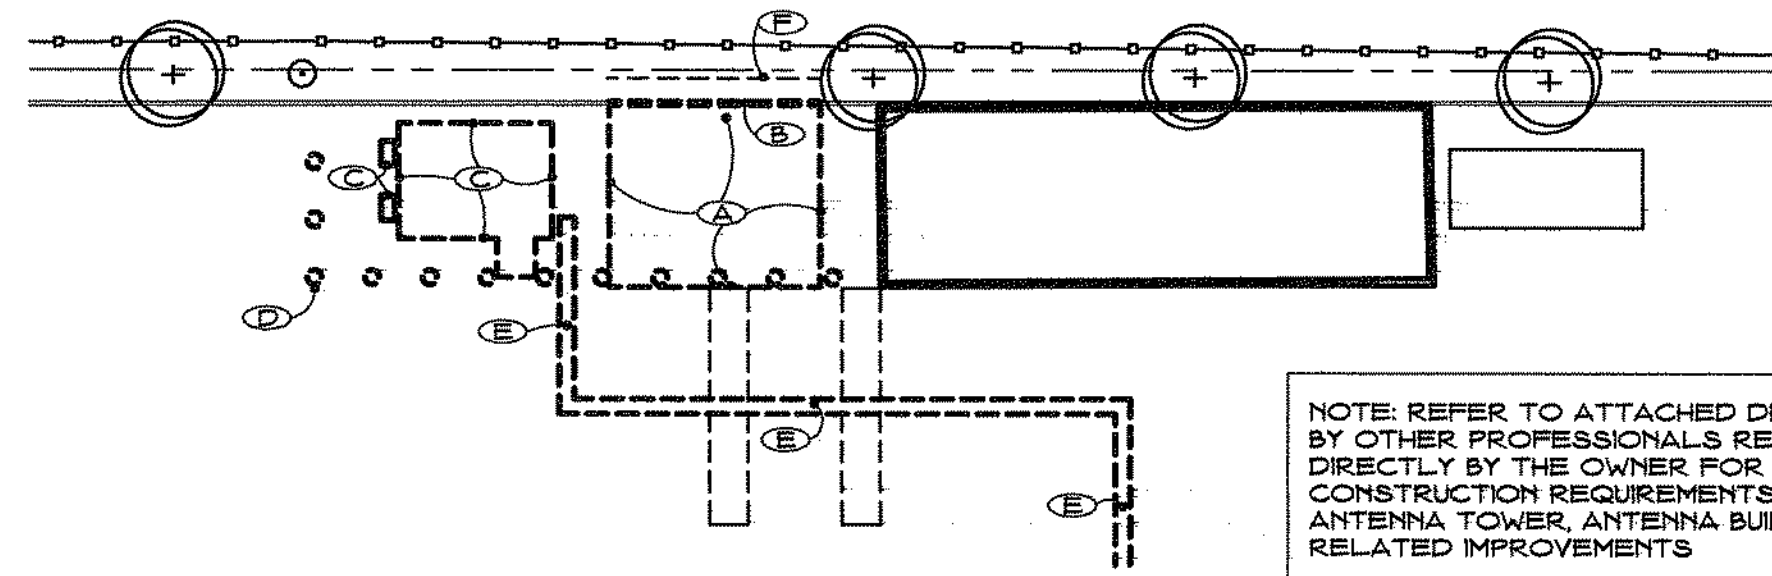- (1) (N) TOWER BUILDING AS DESIGNED BY OTHERS
- (2) (N) ANTENNA TOWER AS DESIGNED BY OTHERS
- (3) (N) POWER FEED TO TOWER BUILDING - REFER TO ELECTRICAL SHEETS
- (4) (E) FENCE TO REMAIN - PROTECT
- (5) (E) TREE TO REMAIN - PROTECT
- (6) (E) POLE-MOUNTED LIGHT TO REMAIN - PROTECT
- (7) (E) TRASH ENCLOSURE TO REMAIN - PROTECT
- (8) (E) STORAGE TRAILER TO BE MOVED TO THIS LOCATION BY OWNER - PROTECT
- (9) (N) TRAFFIC BOLLARDS PER (3) TYPICAL FOR (12)
- (10) (E) SPEED BUMPS - PATCH ASPHALT AS REQUIRED
- (11) RE-ROUTE (E) IRRIGATION LINES/HEAD AS REQUIRED FOR (N) ANTENNA TOWER
- (12) (N) CONCRETE CURB TO MATCH (E) WHERE REMOVED



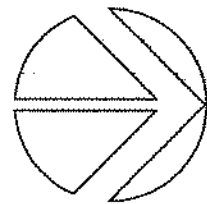NOTE: REFER TO ATTACHED DRAWINGS BY OTHER PROFESSIONALS RETAINED DIRECTLY BY THE OWNER FOR THE CONSTRUCTION REQUIREMENTS FOR THE ANTENNA TOWER, ANTENNA BUILDING, AND RELATED IMPROVEMENTS





SCALE: 1" = 20'-0"

1 ENLARGED SITE PLAN - DEMOLITION

KEY NOTES (THIS SHEET ONLY)

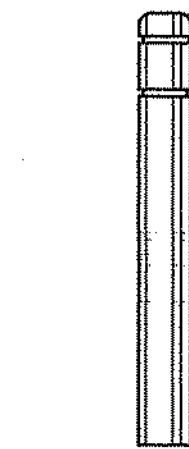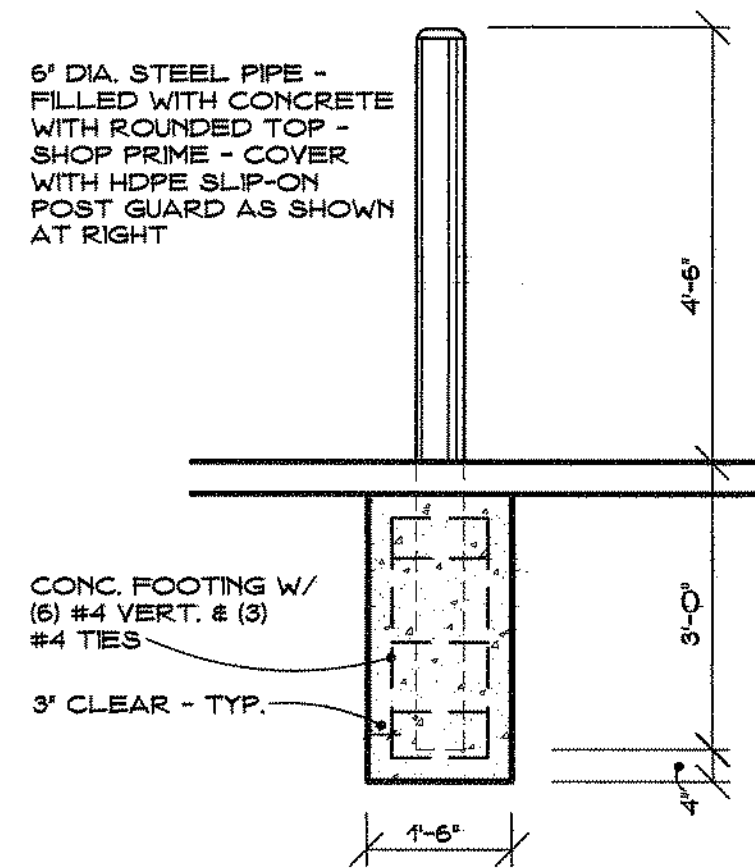
- (A) SAW CUT AND REMOVE (E) ASPHALT AS REQUIRED FOR (N) ANTENNA TOWER
- (B) SAW CUT AND REMOVE (E) CONC. CURB AS REQUIRED FOR (N) ANTENNA TOWER
- (C) SAW CUT AND REMOVE (E) ASPHALT AS REQUIRED FOR (N) ANTENNA BUILDING
- (D) CORE (E) ASPHALT AS REQUIRED FOR (N) BOLLARDS - TYPICAL FOR (12)
- (E) SAW CUT AND REMOVE (E) ASPHALT AS REQUIRED FOR (N) POWER FED
- (F) RE-ROUTE (E) IRRIGATION LINES/HEAD AS REQUIRED FOR (N) ANTENNA TOWER



HDPE SLIP-ON POST GUARD WITH REFLECTIVE TAPE - 'POST GUARD' BY ENCORE COMMERCIAL PRODUCTS, OR EQUAL - COLOR PER ARCHITECT - TRIM HEIGHT TO FIT - INSTALL WITH FOAM TAPE PER MANUFACTURER

3 TRAFFIC BOLLARD

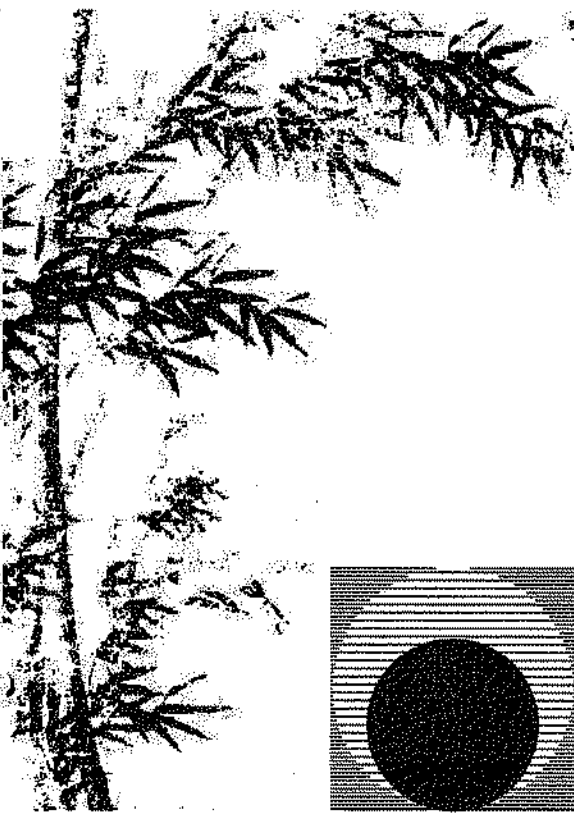NO SCALE





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Enlarged Site Plan

Date:	08/08/20
Project:	19-700
Scale:	1" = 20'
Sheet No.:	SD2

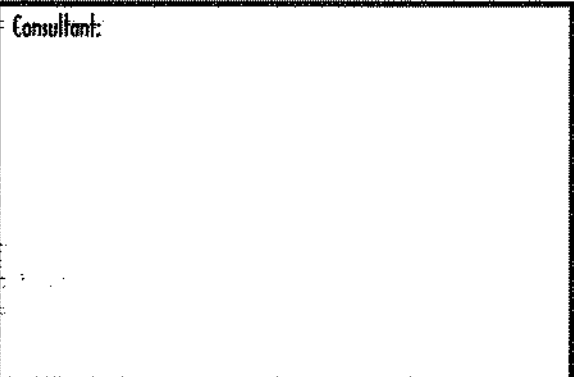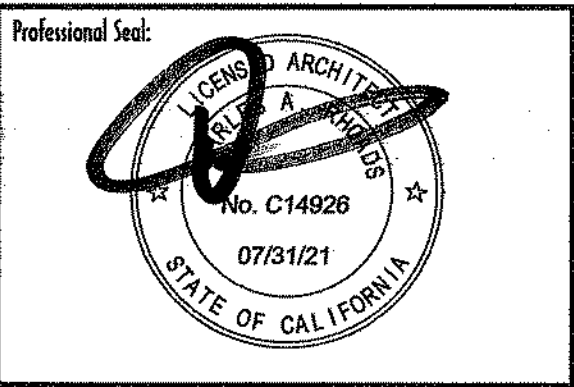Of 2 sheets